VICINITY MAP

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LENGTH, LOI LIGHTWEIGHT LINTEL LIVE LOAD LOUVER

BOY SCOUTS OF AMERICA BLUE RIDGE MOUNTAINS COUNCIL CLAYTOR LAKE AQUATICS BASE

DINING HALL LOWER LEVEL BUILDOUT **PULASKI COUNTY, VIRGINIA**

BALZER PROJECT NO. B0600007.01

DRAWING ABBREVIATIONS **SYMBOLS & MATERIALS** MAN HOLE MANUFACTURER MASONRY OPENING WALL TAG MAXIMUM **NOTE TAG** WINDOW NUMBER TAG **REVISION TAG** MISCELLANEOUS MOLDING, MOULDING BLKG BD BOT BRK BLDG INDICATES ELEVATION OR DETAIL **DETAIL** NUMBER DETAIL IS DRAWN CASEMENT CEILING CEILING HEIGI CENTER LINE CERAMIC TILE DRAWING DESIGNATION-CHAIR RAIL PAINTED PARTICAL BOARD CLOSET COLUMN CONCRETE CONCRETE MASONRY UNIT CONSTRUCTION COL CONC CMU CONST CONT CJ CORR CTR CRS PLASTIC LAMINATE PLATE GLASS PLYWOOD POLYVINYL CHLORIDE SHEET DESIGNATION -**WALL SECTION BUILDING SECTION** POUNDS/SQUARE FOOT COUNTER COURSE POUNDS/SQUARE INCH PRECAST CONCRETE DEMOLITION DEPARTMENT DIAGONAL DIAMETER DIMENSION PROPERTY LINE PROPOSED **ELEVATION** QUARRY TILE DITTO DIVISION RADIUS DOOR DOUBLE HUNG RECEPTACLE/ELECTRICAL REFRIGERATOR REINFORCED USE NUMBERS HORIZONTALLY, LEFT TO RIGHT REMOVE REQUIRED RESILIENT RETURN RETURN AIR USE LETTERS VERTICALLY, TOP TO BOTTOM ECTRIC WATER COOLER LECTRICAL PANEL BOARI EP ELEV EMER ENCL ENG ENT EQ EQUIP EXH EXIST EB ROUGH OPENING EQUAL EQUIPMENT SCHEDULE SECTION SHEATHING SHEET **EXISTING WALLS & DOORS** SIMILAR SLIDING DOOR EXTERIOR SQUARE FEET STAINLESS STEEL **NEW WALLS & DOORS** STORAGE STRUCTURAL FIREPLACE FLUOR FTG FDN FRA FBO TELEPHONE TELEVISION THICK(NESS) THIN COAT PLASTER THRESHOLD THROUGH TOILET TONGUE and GROOVE TOP OF SLAB TOP OF STEEL TOP OF WALL **DEMOLITION WALLS & DOORS** TREAD TYPICAL UNFINISHED HDWR HWD HDR HTG HVAC HD HGT HOC HM HORIZ HB HW HARDWARE HEADER HEATING **ALUMINUM** HEATING/VENTING/AIR CONDITIONING VENT THRU ROOF **BRICK (SECTION) POROUS FILL** VINYL WALL COVERING CONCRETE INSIDE DIAMETER C.M.U. WOOD BLOCKING INTERIOR WINDOW WIRE GLASS EARTH OR COMPACTED FILL WOOD SHIMS JANITOR'S CLOSET WITHOUT KITCHEN WOOD FINISH INSULATION BATTS

INSULATION RIGID



ENGINEERS

SURVEYORS

PROJECT DIRECTORY

OWNER **Boys Scouts of America** Contact: Greg Harmon 2131 Valley View Blvd. Roanoke, Virginia 24012

ARCHITECT Balzer and Associates, Inc. **Contact: Robert Pilkington** 448 Peppers Ferry Road Christiansburg, Virginia 24073 Phone: (540) 381-4290 FAX: (540) 381-4291

Phone: (540) 529-5985

CODE ANALYSIS

This set of construction documents addresses an upfit of a shell space in the lower floor of an existing Assembly/Office/Educational use building at the referenced address. Accessibility is provided to the Lower Level via vehicular access road (with handicap parking/dropoff at the lower level closest to the entry doors) as allowable per IBC 1104.2, Exception

CODE EDITION: **USE GROUP:** CONSTRUCTION TYPE:

2006 VUSBC (2006 IBC w/ Amendments) A-2/A-3/B/E (Non- separated mixed use) (IBC Table 503) 5B (Combustible, Non-protected)

TABULAR ALLOWABLE AREA SPINKLER INCREASE: OPEN PERIM. INCREASE

200% (PER IBC 506.3) = 12,000 S.F. 0% (NOT REQUIRED; NONE TAKEN)

TOTAL ALLOWABLE AREA:

DESIGNED BLDG. AREA:

Main Level= 10,865 S.F. (including porch) Lower Level= 6,296 S.F. (excludes porch)

6,000 S.F. (per floor) (A-3 CONTROLS)

ALLOWABLE BUILDING HEIGHT: 2 ST./60' (per IBC Table 503/IBC Section 504.2) **DESIGNED BUILDING HEIGHT:** 2 ST./ ±55' (not including cupola)

FIRE PROTECTION SYSTEM (IBC Chapter 9):

A. Building shall be protected throughout with an automatic sprinkler system, installed in accordance with all requirements in IBC Chapter 9, per IBC Section 506.3, as required for A-use buildings greater than 300 occupants per IBC 903.2.1.2. Sprinkler shall include porch area on Main Level. On Lower Level sprinkler shall be provided in above ceiling space as required for combustible ceiling areas.

B. Building shall be equipped throughout with a automatic fire alarm system that has notification appliances directly linked to automatic sprinkler system, installed in per IBC 907.2.1, Exception. Existing fire alarm system shall be extended as required into new space.

C. Standpipe System NOT REQUIRED per IBC Section 905.3.1 (highest story is only 13' maximum above lowest fire truck access, and lowest level is only 13' maximum below highest fire truck access) and 905.3.2 (Group A occupancy with less than 1,000 persons).

OCCUPANT LOAD (IBC Table 1004.1.2):

= 20 occupants Office/restrooms Retail area = 14 occupants = 18 occupants Cafe/service

Total Max. Occupancy = 166 occupants (Lower Level only) (No change to occupancy on Main Level)

EXIT REQUIREMENTS:

Minimum Exits Required (IBC Table 1019.1): Lower Level= 2 Exits Req. (4 Provided)

Minimum Egress Width Required (IBC Table 1005.1): Lower Level= 166 Occs. @ 0.15"= 25" Req. (60" corridors provided)

Maximum Exit Travel Distance (IBC Table 1016.1):

Lower Level= 250' Max. (110' Provided, measured along corridor path)

PLUMBING FIXTURE REQUIREMENTS (IBC Table 2902.1): Note: Toilet facilities shown are for Lower Level only. Toilet facilities

166 Occupants (Lower Level)= 83 men, 83 women

for Main Level shown on main building dwgs.

83 Men @ 1:75 = 2 required (2 provided)

83 Women @ 1:75 = 2 required (2 provided)

83 Men @ 1:200 = 1 required (2 provided)

83 Women @ 1:200 = 1 required (2 provided)

FIRE RATING OF BUILDING ELEMENTS (IBC TABLE 602): NO FIRE RATED BUILDING ELEMENTS REQUIRED PER IBC TABLE 602 (5B CONSTRUCTION, FULLY SPRINKLERED)

DRAWING INDEX

		RE	VIS	SIC	NS						
A	7	6	5	4	3	2	1		DRAWING		
DATE								SHEET NO.	SHEET TITLE		
								T1.1	COVER, CODE ANALYSIS		
							\vdash	A1.1	LOWER LEVEL BUILDOUT PLAN		
								A1.2	SCHEDULES & PLAN DETAILS		
								A1.3	SCHEDULES & DETAILS		
								A1.4	REFLECTED CEILING PLAN		

CODE NOTES

MECHANICAL & ELECTRICAL DESIGN:

THIS PROJECT IS A DESIGN-BUILD PROJECT. AS SUCH, MECHANICAL, PLUMBING & ELECTRICAL DESIGN WILL BE HANDLED BY GENERAL CONTRACTOR'S SUB-CONTRACTORS AND PERMITTED UNDER TRADE PERMITS. DRAWINGS WITH A LICENSED ENGINEER'S STAMP SHALL BE PROVIDED AS REQUIRED BY LOCAL BUILDING OFFICIAL AND VIRGINIA STATE LAW.

CODE NOTES

- 1. ALL LOCKS AND LATCHES SHALL COMPLY WITH IBC 1008.1.8. ALL DOORS TO BE EQUIPPED WITH LEVER HANDLES 2. PROVIDE EMERGENCY EGRESS LIGHTING PER IBC 1006. MAINTAIN MINIMUM 1FC LIGHT LEVELS IN ALL SPACES PROVIDING EXIT ACCESS, PER IBC 1006.2. PROVIDE EMERGENCY EXIT SIGNS PER IBC 1011. EXIT SIGNAGE SHALL BE INTERNALLY LIGHTED PER IBC 1011.4, AND SHALL BE CONNECTED TO AN EMERGENCY BACKUP POWER SOURCE PER
- 3. INTERIOR FINISH MATERIAL SHALL BE CLASS C OR BETTER IN ROOMS OR ENCLOSED SPACES, AND CLASS B IN
- CORRIDORS PROVIDING EXIT ACCESS PER IBC TABLE 803.5. FLOOR FINISHES TO BE COMPLIANT WITH IBC SECTION 804. 4. FIREBLOCKING SHALL BE INSTALLED IN ALL CONCEALED WALL SPACES AS REQUIRED PER IBC 717. 5. EXPOSED INSULATION MATERIALS SHALL HAVE FLAME SPREAD OF 25 OR LESS, AND SMOKE DEVELOPMENT OF 450 OR LESS PER IBC 719.3. CONCEALED INSULATION MATERIALS SHALL HAVE FLAME SPREAD OF 25 OR LESS, AND SMOKE
- DEVELOPMENT OF 450 OR LESS PER IBC 719.2. 6. PROVIDE PORTABLE FIRE EXTINGUISHERS DURING CONSTRUCTION AND PERMANENTLY IN BUILDING AS REQUIRED PER IBC 906 AND IFC 906. SEE FLOORPLAN FOR PERMANENT LOCATIONS.
- 7. ALL PLUMBING FIXTURES TO BE ADA COMPLIANT. HANDICAP CONTROLS SHALL COMPLY WITH IBC 1109.13. 8. ALL INTERIOR OCCUPIED SPACES SHALL BE PROVIDED WITH EITHER NATURAL OR MECHANICAL VENTILATION IN ACCORDANCE WITH IBC 1203. NATURAL VENTILATION ALLOWED PER IBC 1203.4.1 IN ROOMS WITH OPERABLE
- DOOR/WINDOW AREA AT LEAST 4% OR MORE OF ROOM FLOOR AREAS. 9. ALL FIRE-RATED WALL ASSEMBLIES SHALL BE LABELED ABOVE CEILINGS AT 8'-0" O.C. PER VUSBC 701.2. 10. ALL NEW PIPING (PLUMBING, GAS, ETC.) USED IN THIS PROJECT SHALL BE LABELED ON SITE IN ACCORDANCE WITH ALL 2006 IBC, IMC & IPC APPLICABLE PROVISIONS.
- 11. PROVIDE FLOOR LIVE LOAD SIGNAGE PER IBC 1603.3

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WETLAND DELINEATIONS & STREAM EVALUATION

SITE DEVELOPMENT ENGINEERIN LAND USE PLANNING & ZONING

Balzer and Associates, Inc 448 Peppers Ferry Road, NV Christiansburg, VA 24073 540-381-4290

FAX 540-381-4291

S ROBERT W. PILKINGTON Lic. No. 013210

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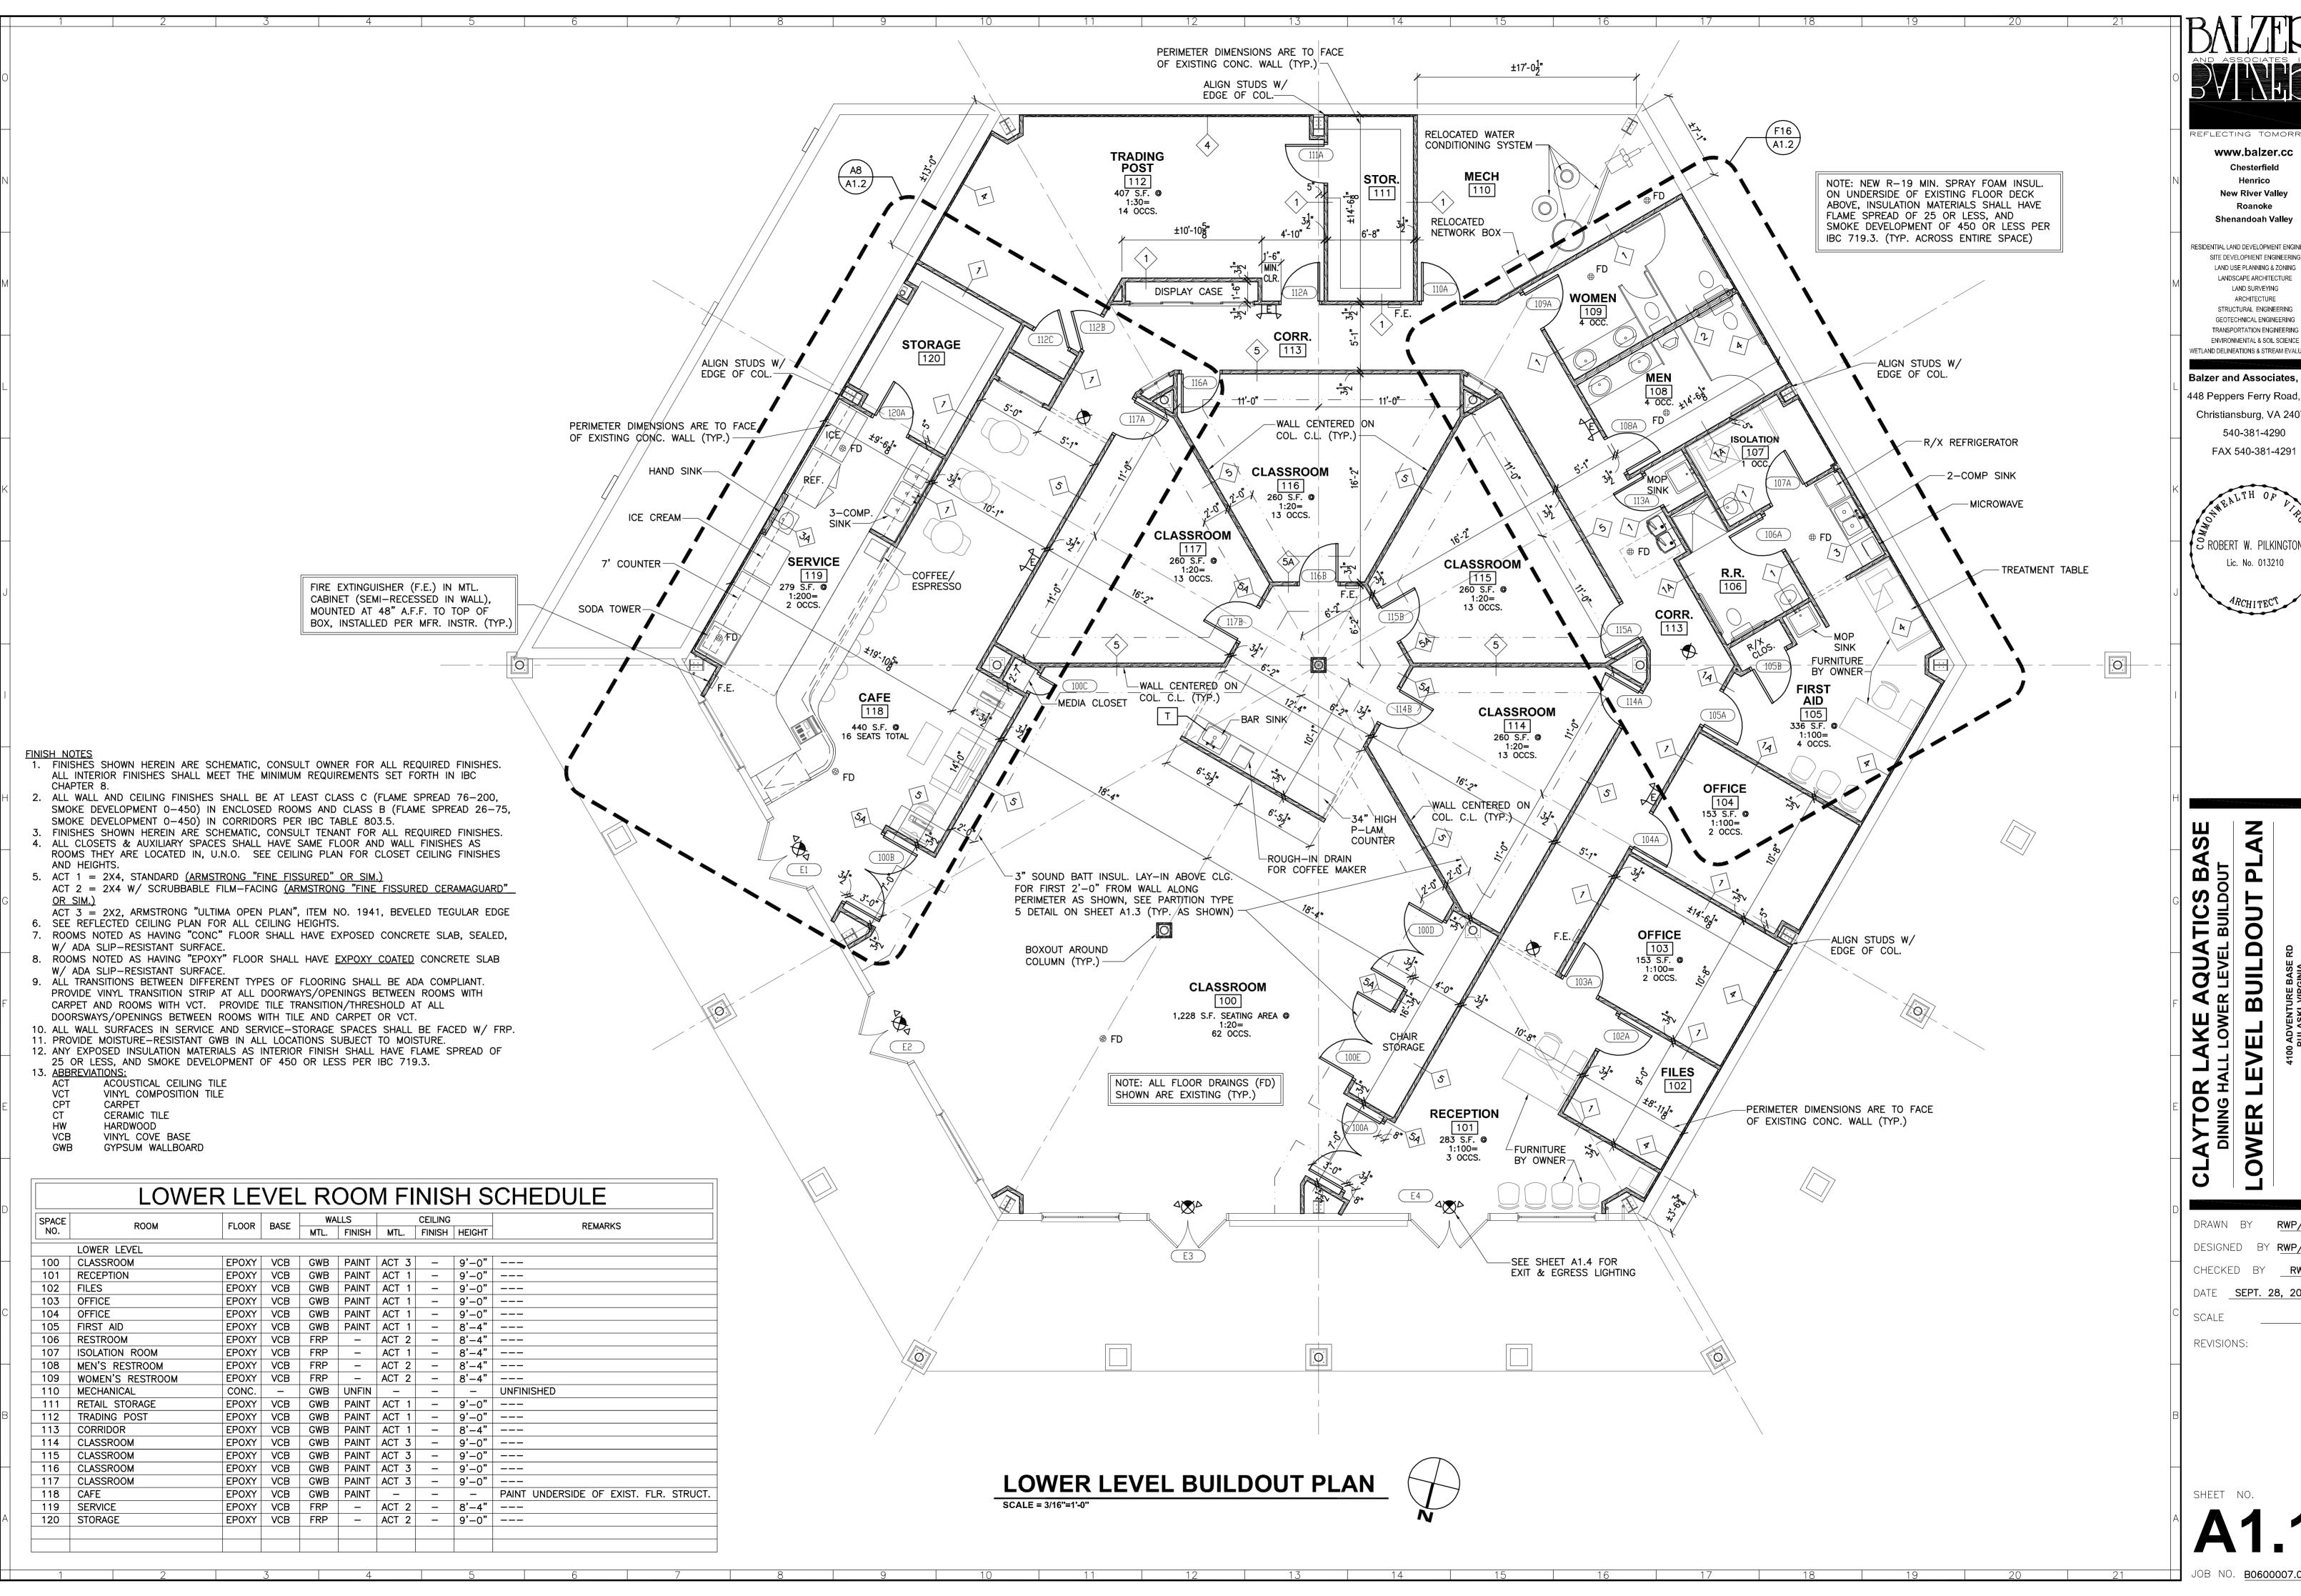
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DESIGNED BY RWP/ARW CHECKED BY **RWP**

DATE **SEPT. 28, 2009**

REVISIONS:



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Balzer and Associates, Inc. 448 Peppers Ferry Road, NW Christiansburg, VA 24073


FAX 540-381-4291

🕏 ROBERT W. PILKINGTON 🖥 Lic. No. 013210

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SITE DEVELOPMENT ENGINEERING

Balzer and Associates, Inc. 448 Peppers Ferry Road, NW Christiansburg, VA 24073

540-381-4290
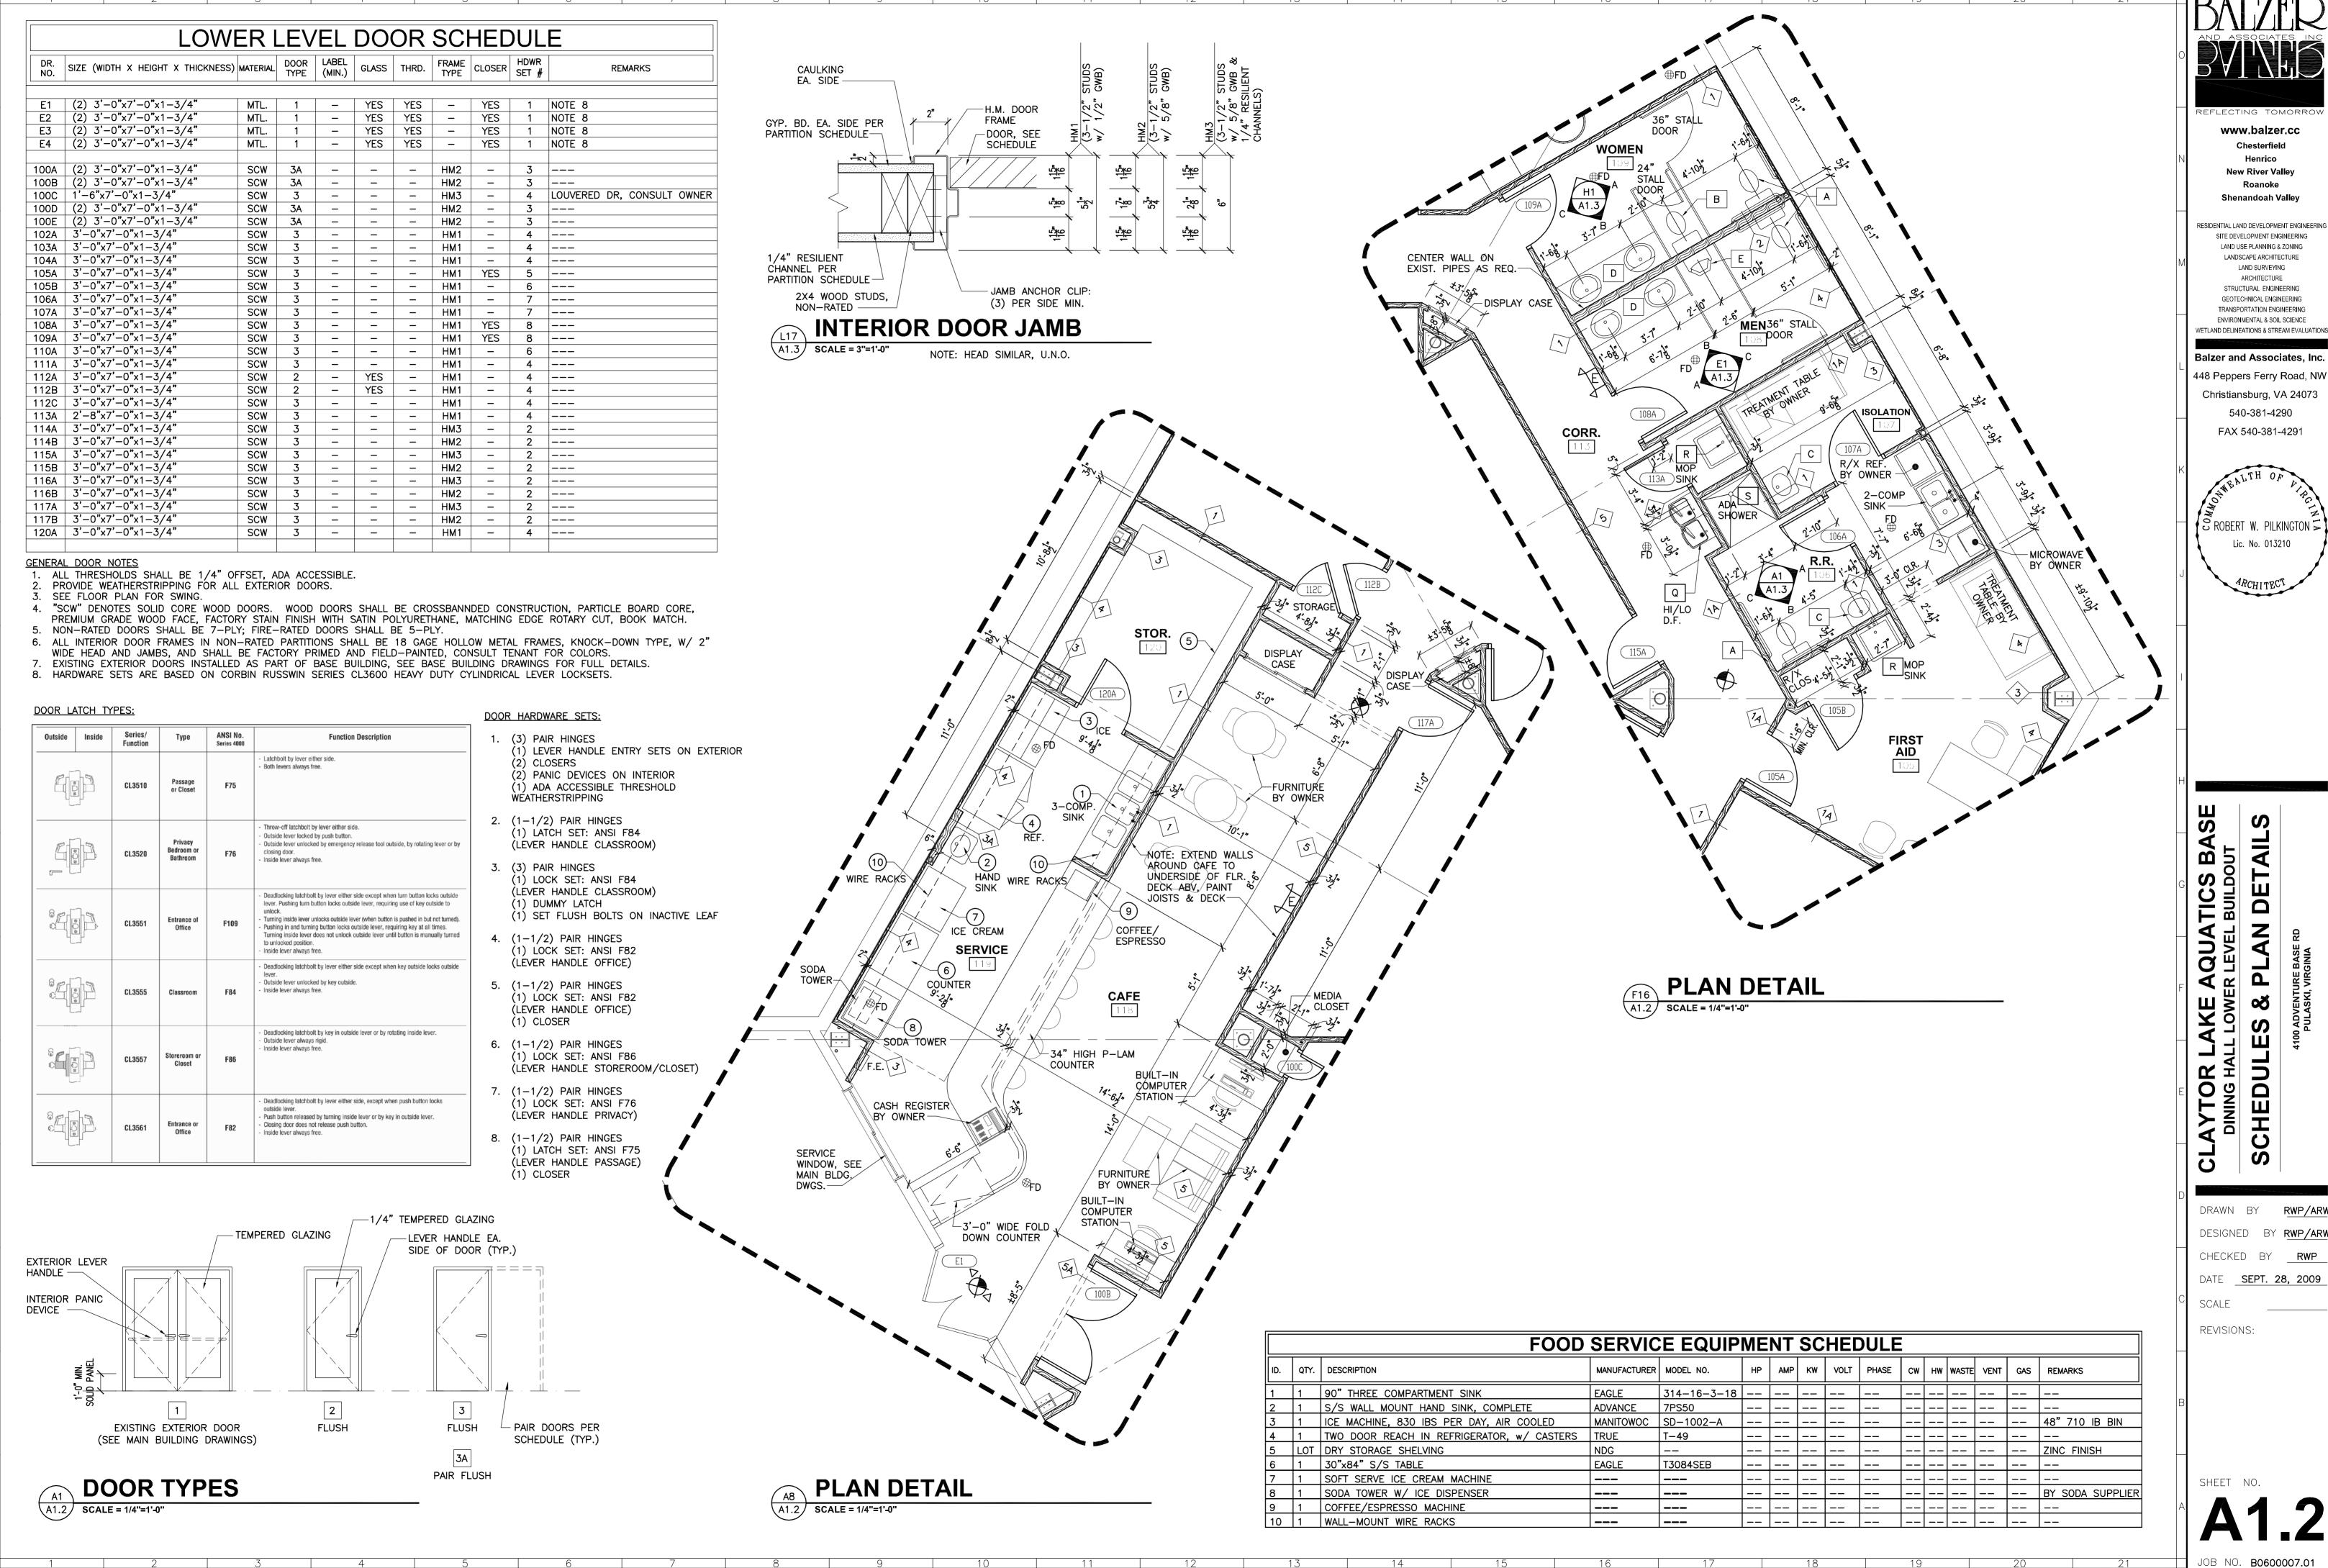
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SCALE

REVISIONS:

SHEET NO.

RESTROOM ACCESSORY SCHEDULE													
ID.	DESCRIPTION	MANUFACTURER	MODEL	NOTES	MOUNTING HEIGHT								
Δ	WATER CLOSET— HANDICAP	тото	CST704	WHITE W/ SEAT	SEAT 17" A.F.F.								
В	WATER CLOSET STANDARD	ТОТО		WHITE W/ SEAT	SEAT 14"± A.F.F.								
C	LAVATORY- WALL HUNG	AMERICAN STANDARD	LUCERNE 0355.012	WHITE W/ ADA FAUCET	34" A.F.F. TO TOP OF SINK RIM								
D	LAVATORY	AMERICAN STANDARD	CADET 0425.444	WHITE W/ ADA FAUCET	34" A.F.F. TO TOP OF SINK RIM								
E	WALL-HUNG URINAL	AMERICAN STANDARD	WASHBROOK 6501.010	WHITE	17" A.F.F. TO TOP OF RIM FOR H.C.; 21" A.F.F. TO TOP OF RIM FOR STANDARD								
F	1-1/2" DIAMETER 42" GRAB BAR	BOBRICK	B-6206.99 X 42	REINFORCED WALL	36" A.F.F. TO CENTER OF BAR								
G	1-1/2" DIAMETER 18" GRAB BAR	BOBRICK	B-6206.99 X 18	REINFORCED WALL	40" A.F.F. TO BOTTOM OF BAR								
Ι	1-1/2" DIAMETER 36" GRAB BAR	BOBRICK	B-6206.99 X 36	REINFORCED WALL	36" A.F.F. TO CENTER OF BAR								
J	SURFACE-MOUNT P.T. DISPENSER	BOBRICK	B-262	STAINLESS STEEL	48" A.F.F. TO BOTTOM								
K	SURFACE-MOUNT T.P. DISPENSER	BOBRICK	B-264	STAINLESS STEEL	24" A.F.F.								
L	SOAP DISPENSER	BOBRICK	B-2112		44" A.F.F. TO BOTTOM OF DISPENSER								
М	MIRROR 18"x36"	BOBRICK	B165-1836		40" A.F.F. TO BOTTOM OF REFLECTING SURFACE								
N	MIRROR 72"x36"	BOBRICK	B165-6036		40" A.F.F. TO BOTTOM OF REFLECTING SURFACE								
Q	HI/LO DRINKING FOUNTAIN	ELKAY	LIEATL8C		34" TO TOP OF LOWER FOUNTAIN SPOUT								
R	MOP SINK	FIAT	MSB2424		_								
S	H.C. SHOWER	AQUARIUS	S4136BF	W/ HAND HELD SHOWER CONTROLS	_								
Т	BAR SINK												


INSULATE ALL EXPOSED H.W. SUPPLY AND DRAIN PIPES.

2. ALL SUBSTITUTE FIXTURES SHALL BE ADA COMPLIANT. 3. TOILET LEVER SHALL BE TO WIDE SIDE OF ROOM OR STALL.

4. PROVIDE 2x WD. BLOCKING BETWEEN STUDS FOR MOUNTING ALL FIXTURES & ACCESSORIES. 5. PROVIDE VENTILATION FANS TO OUTSIDE FOR ALL TOILETS AND JANITOR CLOSETS, OPERATION TO ACTIVATE WHEN LIGHT IS


SWITCHED. ANY VENT PIPE (OR OTHER) PENETRATIONS THROUGH METAL ROOF SHALL BE INSPECTED & VERIFIED BY ROOF INSTALLER OR MANUFACTURER TO INSURE CONTINUANCE OF ROOF WEAHTERTIGHTNESS WARRANTY.

6. TOILET PARTITIONS: 1" SOLID PLASTIC (HDPE) TOILET PARTITION (CAPITAL PARTITIONS, INC. POLY-PRO PLUS. "CONGRESS" SERIES. FLOOR-MOUNTED, OVERHEAD BRACED) W/ 14" TOE SPACE, PROVIDE DOORS W/ HANDICAP HARDWARE IN SIZE INDICATED ON PLAN

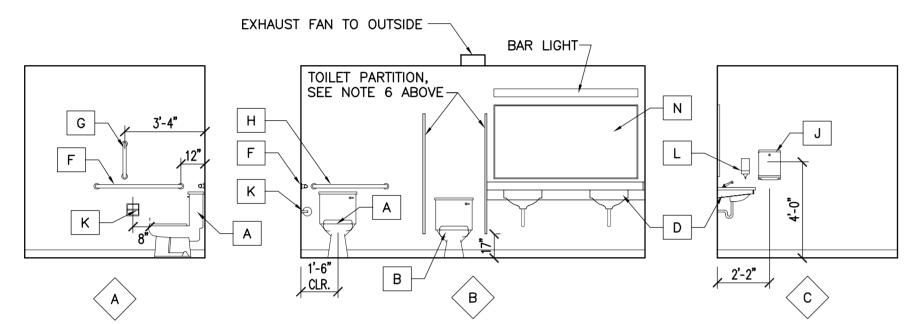


WOMEN'S RESTROOM #109

A1.3 | SCALE = 1/4"=1'-0"

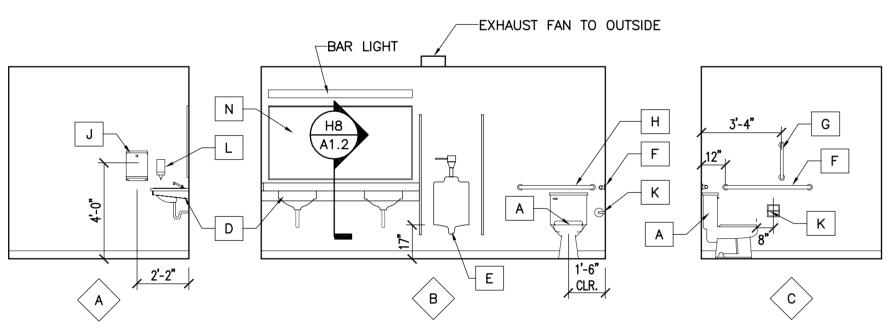


MEN'S RESTROOM #109 A1.3 SCALE = 1/4"=1'-0"

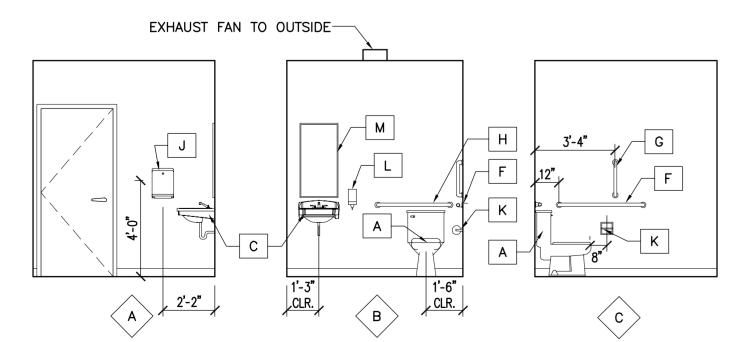


RESTROOM #106

\A1.3 / SCALE = 1/4"=1'-0"

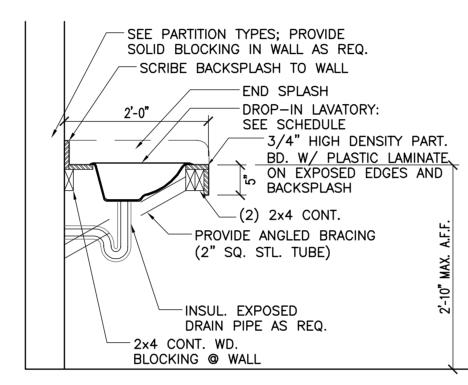

LAVATORY DETAIL

A1.2 | SCALE = 3/4"=1'-0"

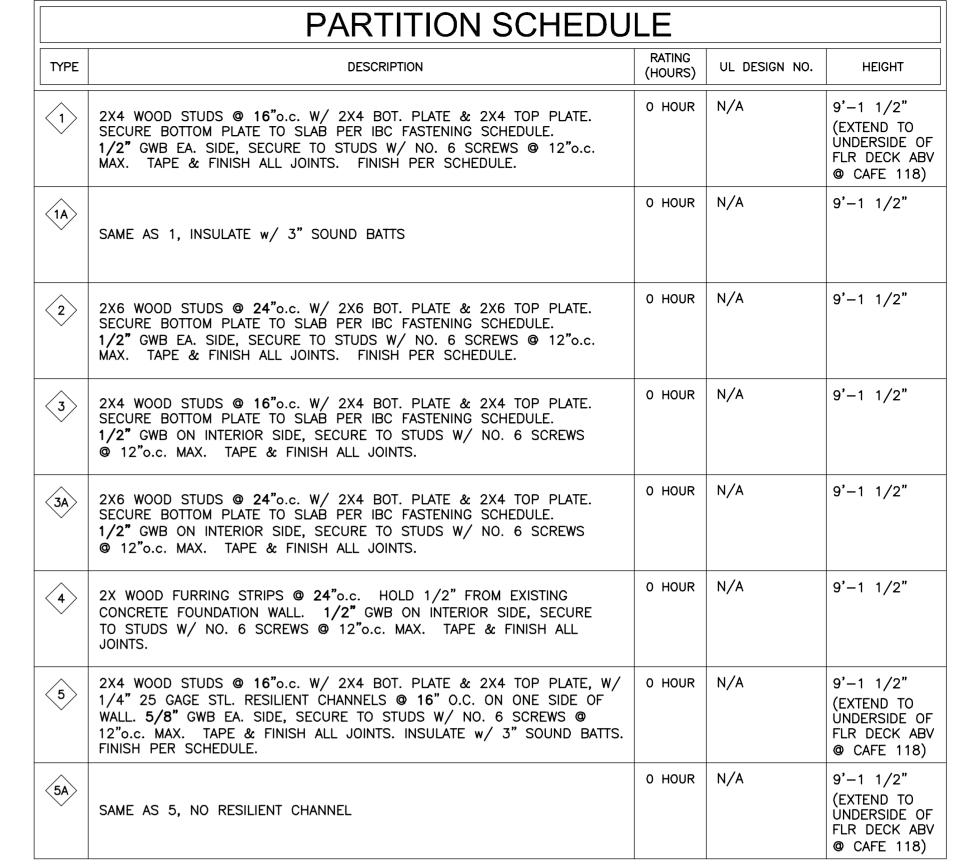


GENERAL PARTITION NOTES:

1. INSTALL CONT. 2X FIRE-BLOCKING @ ALL DROP CEILING LEVEL(S) AND CONT. 2X BLOCKING @ MID-HEIGHT IN ALL PARTITIONS.

ALL PARITITIONS SHALL BE FINISHED PER FINISH SCHEDULE. PROVIDE MOISTURE RESISTANT GYPSUM BOARD IN ALL WET OR DAMP ENVIRONMENTS.

4. PROVIDE TILE BACKER BOARD IN LIEU OF GWB BEHIND ALL WALL TILE, SEE INTERIOR DETAILS FOR TILE LOCATIONS.

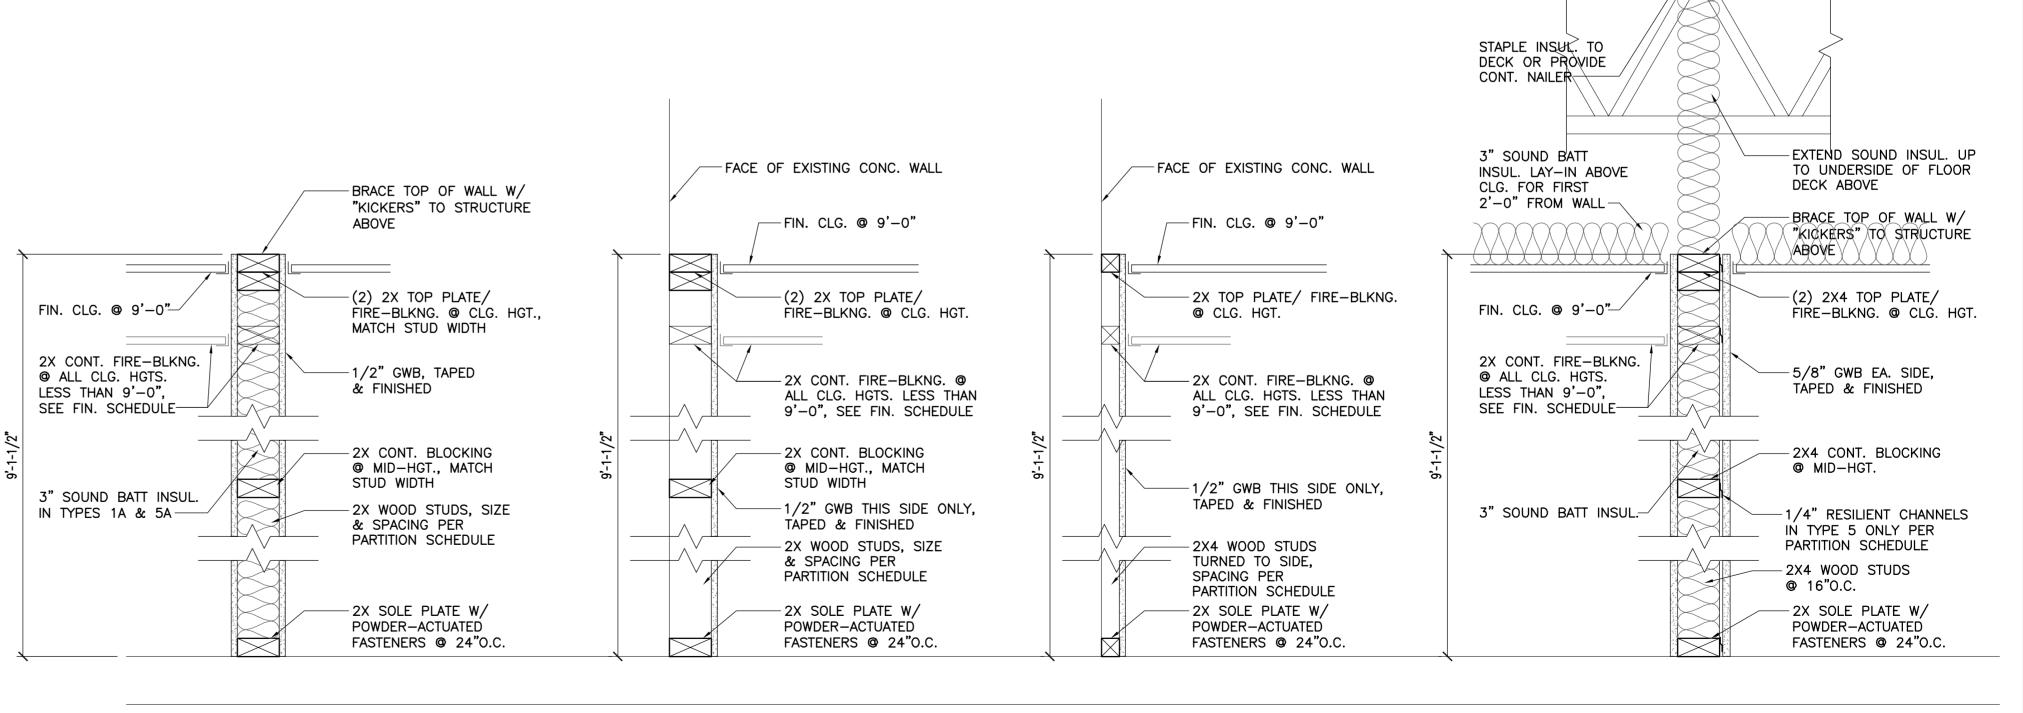

4

 $\langle 3 \rangle \langle 3A \rangle$

PARTITION DETAILS SCALE = 1 1/2"=1'-0"

 $\langle 1 \rangle \langle 1A \rangle \langle 2 \rangle$

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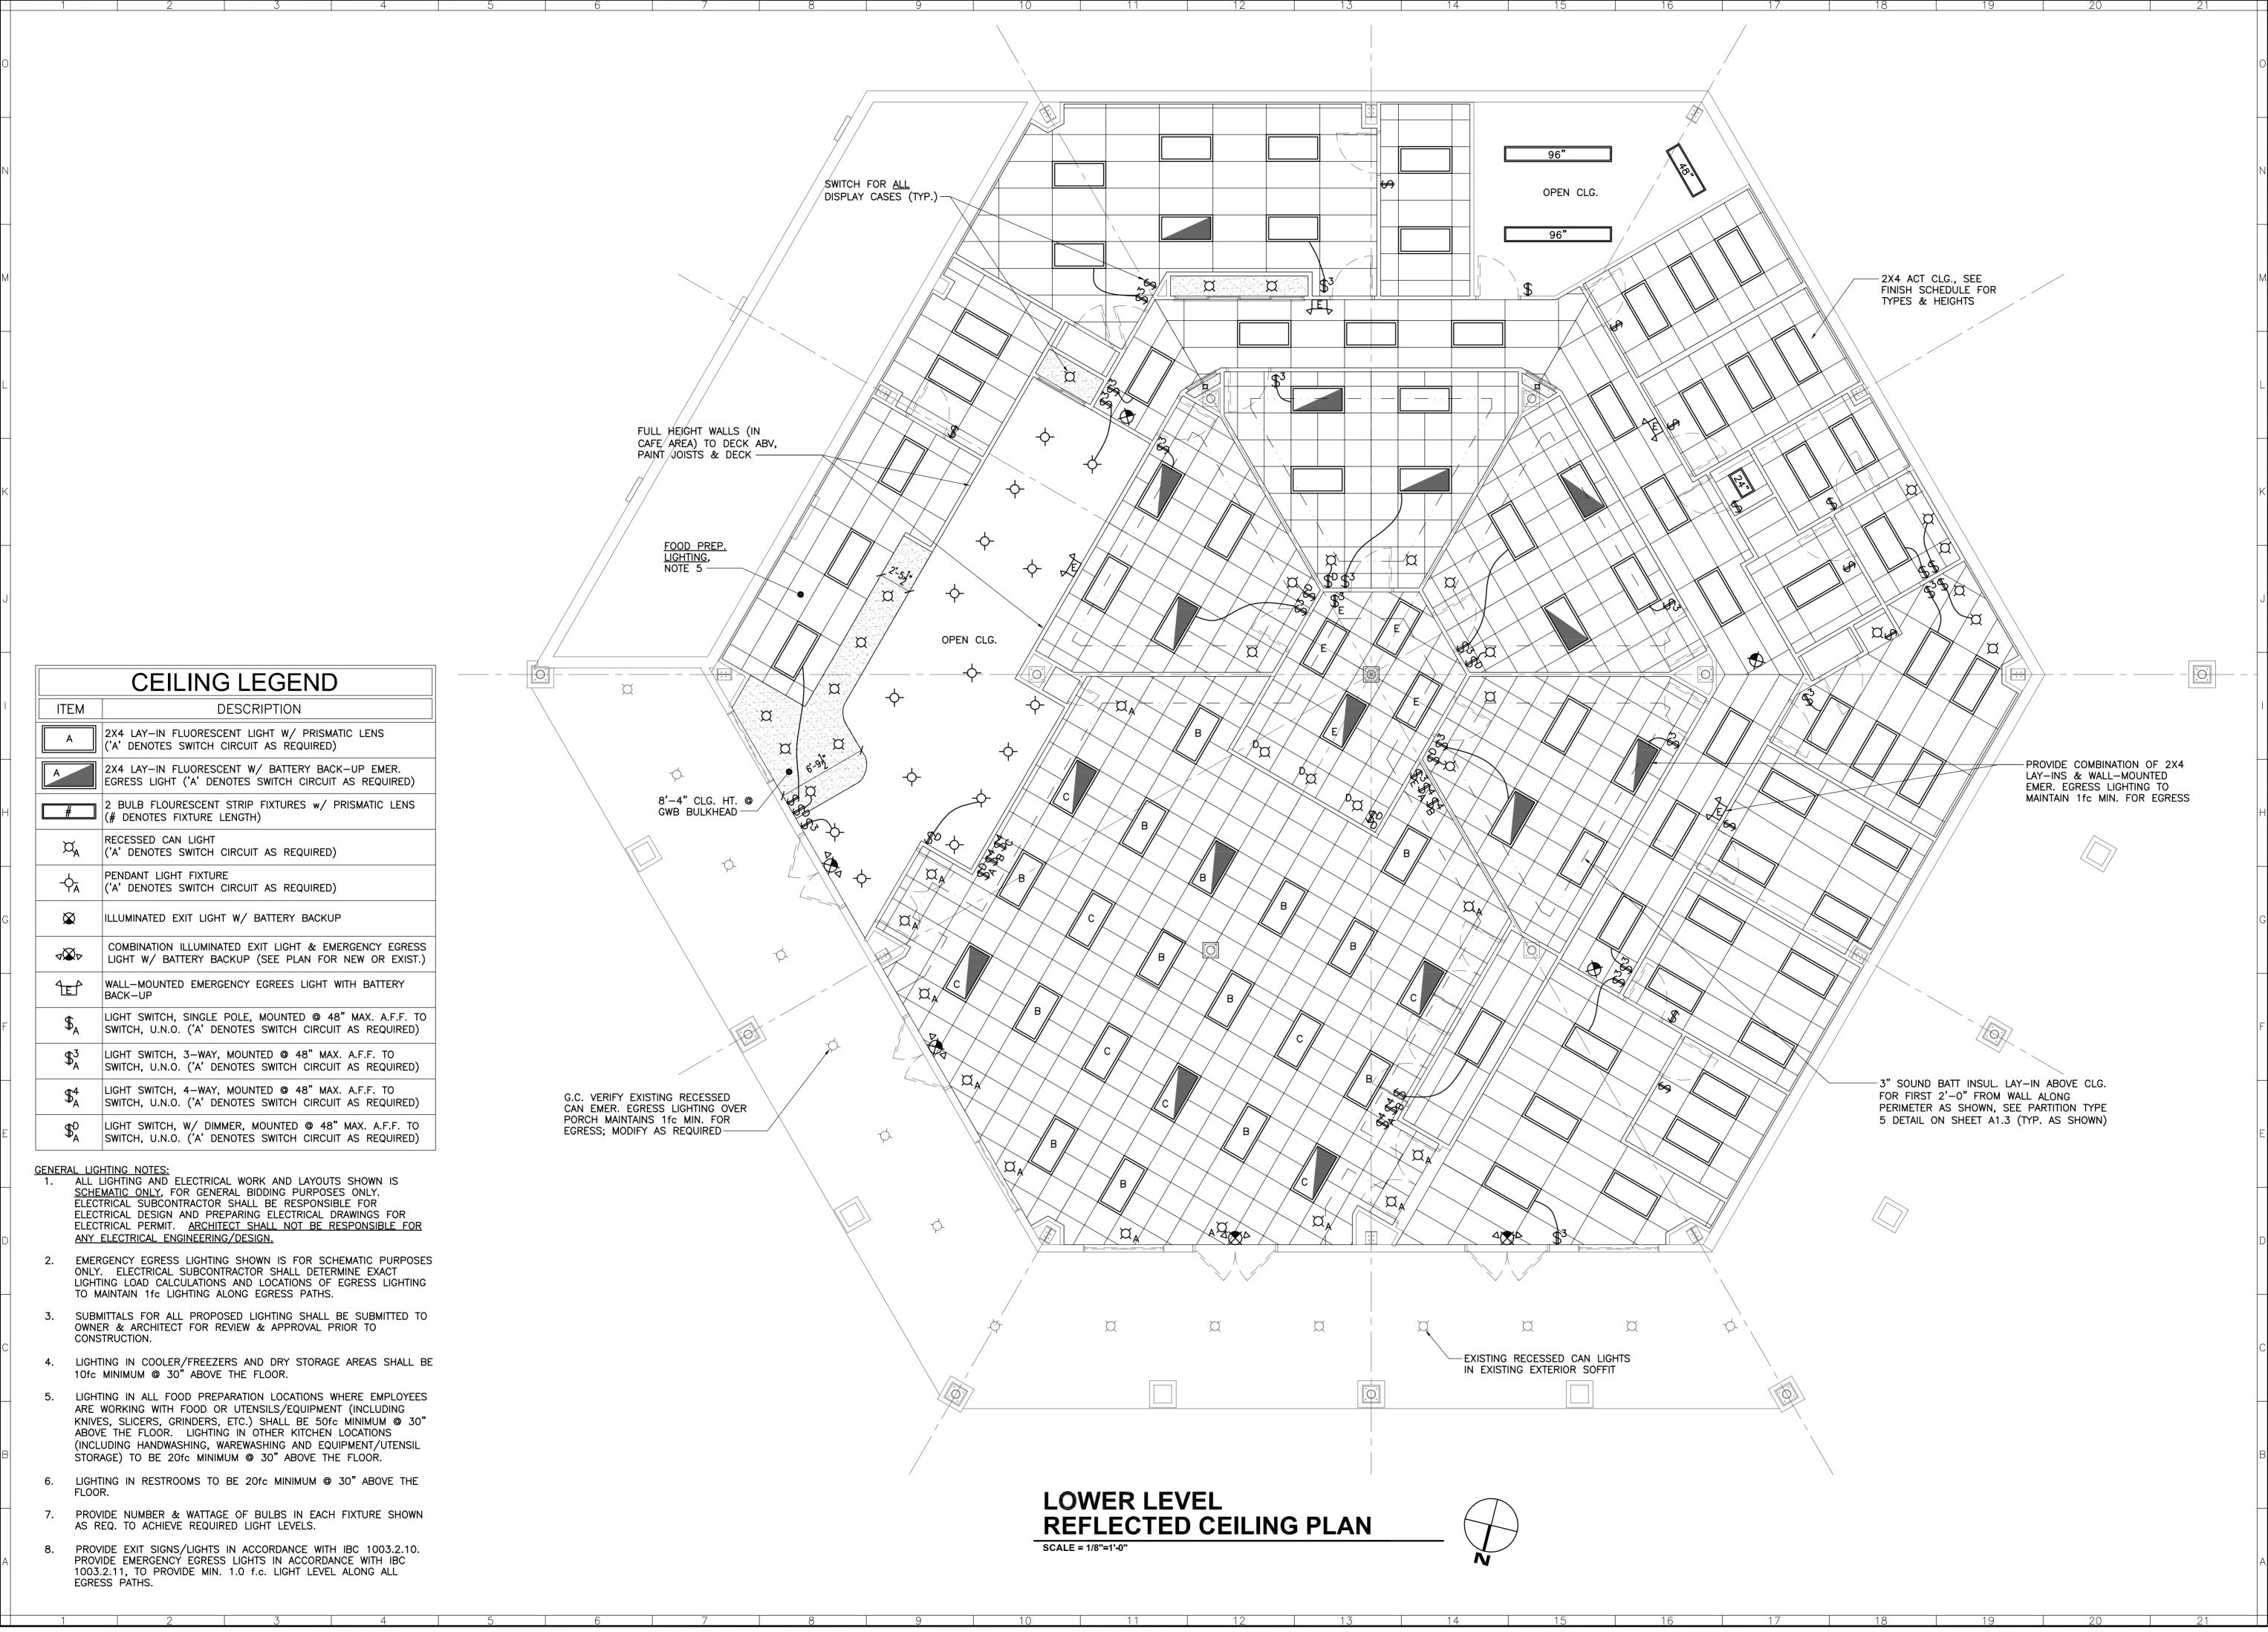
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Balzer and Associates, Inc. 448 Peppers Ferry Road, NW

Christiansburg, VA 24073

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